



DO NOT SCALE FROM THIS DRAWING. USE FIGURED DIMENSIONS IN ALL CASES. VERIFY DIMENSIONS ON SITE AND REPORT ANY DISCREPANCIES TO THE DESIGNERS IMMEDIATELY. THIS DRAWING TO BE READ IN CONJUNCTION WITH THE DESIGNERS © THIS DRAWING IS COPYRIGHT AND MAY ONLY BE REPRODUCED WITH THE DESIGNERS PERMISSION.

NOTES

1. ALL DRAWINGS ARE TO BE READ IN CONJUNCTION WITH ALL RELEVANT SPECIFICATIONS, BILLS OF QUANTITIES, ARCHITECTURAL, SERVICES AND ENGINEERING DRAWINGS.
2. ALL LEVELS ARE IN METRES RELATED TO DATUM: ORDNANCE DATUM MALIN HEAD REFERENCE SYSTEM: IRISH TRANSVERSE MERCATOR (ITM) GEOD: OSGM15
3. ALL DIMENSIONS ARE IN MILLIMETRES, UNLESS NOTED OTHERWISE.
3. ANY DISCREPANCIES BETWEEN THESE DOCUMENTS SHALL BE BROUGHT TO THE ATTENTION OF THE ENGINEER.
4. DRAWINGS ARE NOT TO BE SCALED.
5. AERIAL IMAGERY, WHEN USED, IS SOURCED FROM MICROSOFT BING MAPS THROUGH THE OPEN LICENSING AGREEMENT WITH AUTODESK.

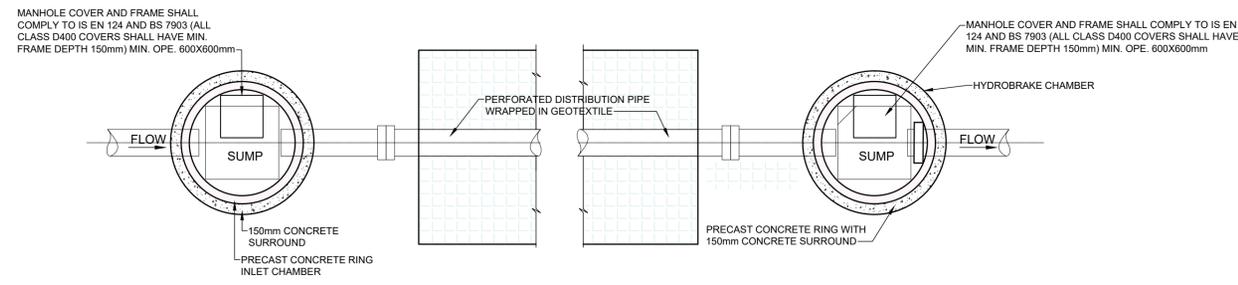


ATTENUATION TANK - DETAIL
SCALE : 1:50

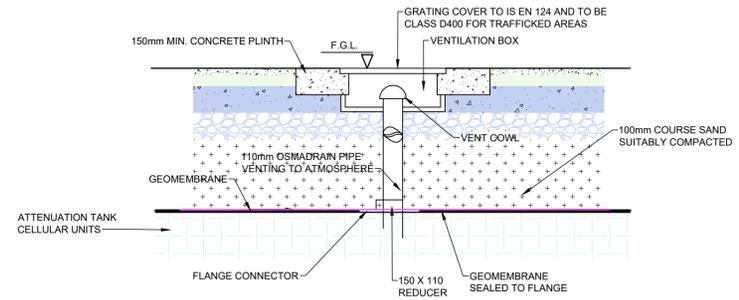

TYPICAL AIR VENT SYSTEM DETAIL
SCALE : 1:20
NOTE: VENTING DETAILS IN ACCORDANCE WITH MANUFACTURER'S DETAILS, REQUIREMENTS AND RECOMMENDATIONS

NOTE:
PROPOSED CELLULAR ATTENUATION SYSTEM TO BE PERMAVOID (OR SIMILAR APPROVED) DESIGN FOR THE RUN OFF RATE.
FOR SIZE AND REQUIRED VOLUMES FOR ATTENUATION TANK REFER TO STORM DRAINAGE LAYOUT DRAWING
FOR PIPE INVERTS AND COVER LEVELS REFER TO DRAWINGS

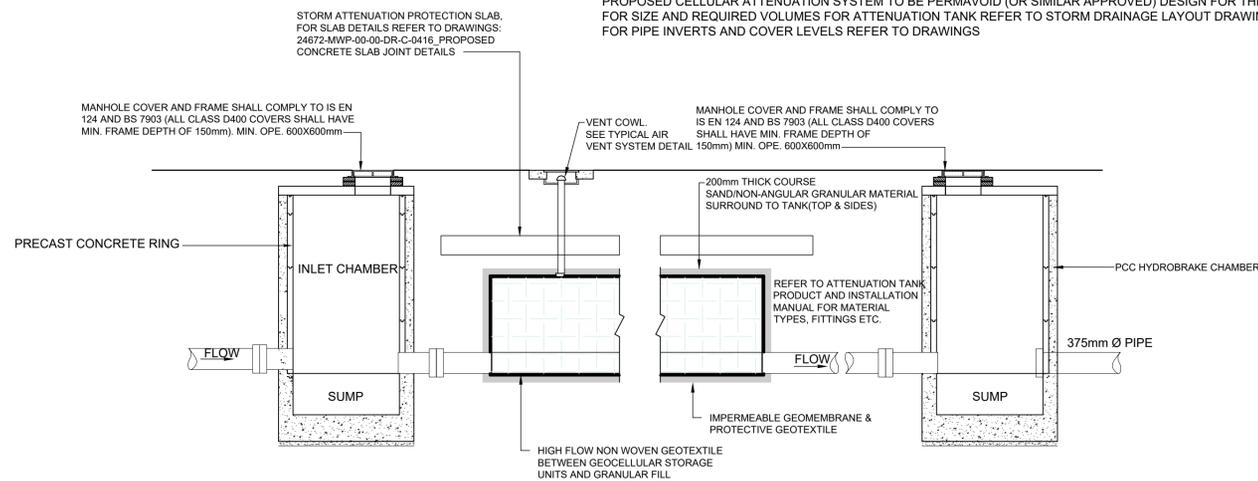

TYPICAL LONGITUDINAL SECTION THROUGH ATTENUATION SYSTEM
SCALE : 1:20

P01	11-03-25	ISSUED FOR INFORMATION	SR	IB
REV	DATE	DESCRIPTION	BY	APP

PROJECT: DREHID SUBSTATION

TITLE: STANDARD ATTENUATION TANK

CLIENT: NORTH KILDARE WF LTD.



DRAWN: SR	CHECKED: CF	APPROVED: IB
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PROJECT NUMBER: 23727	DATE: MAY 24	SCALE @ A1: AS SHOWN
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STATUS DESCRIPTION: FOR INFORMATION	STATUS: S2
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DRAWING NUMBER: 23727 - MWP -SS- ZZ -DR-C- 2402	REV: P01
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